

PLUMBING SYMBOL LIST

NOTE: This is a standard symbol list and not all items listed may be used.

Abbreviations

(A) ABANDON IN PLACE
AFF ABOVE FINISHED FLOOR
AP ACCESS PANEL
AR ACID-RESISTANT
& AND
A AQUASTAT, ARCHITECT, ANCHOR, AMPHERE
@ AT
BFP BACKFLOW PREVENTER
BV BALANCING VALVE
BFF BELOW FINISHED FLOOR
BF BLIND FLANGE
BTUH BRITISH THERMAL UNITS PER HOUR
BLDG BUILDING
CV CHECK VALVE
CO CLEANOUT
CW COLD WATER
CD CONDENSATE DRAIN
CONT. CONTINUATION
CFH CUBIC FEET PER HOUR
CFS CUBIC FEET PER SECOND
(X) DEMOLISH
DW DISHWASHER, DOMESTIC WATER
DET DOMESTIC EXPANSION TANK
DCVA DOUBLE CHECK VALVE ASSEMBLY
DN DOWN
DS DOWNSPOUT
DSN DOWNSPOUT NOZZLE
D DRAIN
DFU DRAINAGE FIXTURE UNIT
DWV DRAINAGE, WASTE AND VENT
DF DRINKING FOUNTAIN
EWC ELECTRIC WATER COOLER
EWH ELECTRIC WATER HEATER
ELECT ELECTRICAL
ESV ELECTRONIC SOLENOID VALVE
EEW EMERGENCY EYE WASH
ESH EMERGENCY SHOWER
(E) EXISTING
EJ EXPANSION JOINT
FT FEET
FPS FEET PER SECOND
FFE FINISHED FLOOR ELEVATION
F FIRE, FAHRENHEIT
FC FLEXIBLE CONNECTOR
FL FLOOR
FCO FLOOR CLEANOUT
FD FLOOR DRAIN
FS FLOOR SINK, FLOW SWITCH
FV FLUSH VALVE
' FOOT, FEET
(F) FUTURE
GPH GALLONS PER HOUR
GPM GALLONS PER MINUTE
GD GARBAGE DISPOSER, GARAGE DRAIN
GWH GAS WATER HEATER
GW GREASE WASTE
HD HEAD, HUB DRAIN
HP HEAT PUMP, HORSE POWER, HOUSEKEEPING PAD
HVAC HEATING, VENTILATING AND AIR CONDITIONING
HZ HERTZ
HB HOSE BIBB
HW HOT WATER
HWFU HOT WATER FIXTURE UNIT
HWR HOT WATER RETURN
IN, " INCHES
IW INDIRECT WASTE
INV INVERT ELEVATION
KW KILOWATT
L LAVATORY
MW MAKE-UP WATER
MAX MAXIMUM
HG MERCURY
MIN MINIMUM
MX MIXING VALVE
MS MOP SINK
MH MOUNTING HEIGHT, MANHOLE
(N) NEW
NPCW NON-POTABLE COLD WATER
NOP NORMALLY OPEN
N NORTH
N/A NOT APPLICABLE
NIC NOT IN CONTRACT
NTS NOT TO SCALE
NUMBER
NO. NUMBER
OD OVERFLOW DRAIN, OUTSIDE DIAMETER
OFCI OWNER FURNISHED, CONTRACTOR INSTALLED
OFOI OWNER FURNISHED, OWNER INSTALLED
PH PHASE
PLBG PLUMBING
P PLUMBING, PUMP
POC POINT OF CONNECTION
PSI POUNDS PER SQUARE INCH
PD PRESSURE DROP, PLUMBING DEMOLITION, PUMPED DISCHARGE
PG PRESSURE GAUGE
PRV PRESSURE REDUCING VALVE
PS PRESSURE SWITCH
QTY QUANTITY
RWL RAINWATER LEADER
RBPB REDUCED PRESSURE BACKFLOW PREVENTER
RV RELIEF VENT, RELIEF VALVE
(R) RELOCATE / RELOCATED LOCATION
RPM REVOLUTIONS PER MINUTE
RD ROOF DRAIN
SAN SANITARY
SJ SEISMIC JOINT
SB SERVICE BOX
SS SERVICE SINK
SHT SHEET
SA SHOCK ARRESTOR
SH SHOWER
SOV SHUT OFF VALVE
S, SK SINK
SF SQUARE FEET
SD STORM DRAIN
SP SUMP PUMP, STATIC PRESSURE
TEMP TEMPERATURE
T&P TEMPERATURE AND PRESSURE
T TEMPERATURE, THERMOMETER
TP TRAP PRIMER, TOTAL PRESSURE
TD TRENCH DRAIN
TYP TYPICAL
U, UR URINAL
V VACUUM, VENT, VOLT
VFD VARIABLE FREQUENCY DRIVE
VS VENT STACK
VTR VENT THRU ROOF
WCO WALL CLEANOUT
WB WASHER BOX
W WASTE
WS WASTE STACK
WC WATER COLUMN
WC WATER COLUMN, WATER CLOSET
WHA WATER HAMMER ARRESTOR
WH WATER HEATER, WALL HYDRANT
WSFU WATER SUPPLY FIXTURE UNIT
W/ WITH

Control Symbols

AI ANALOG INPUT TO DDC PANEL
AO ANALOG OUTPUT FROM DDC PANEL
DP DIFFERENTIAL PRESSURE SENSOR
DI CT DIGITAL INPUT CURRENT TRANSFORMER
DI DIGITAL INPUT TO DDC PANEL
DO DIGITAL OUTPUT FROM DDC PANEL
DO SIS DIGITAL OUTPUT START/STOP SIGNAL
FM FLOW METER
I E LINE VOLTAGE THERMOSTAT
General
CONTINUATION
DETAIL NUMBER AND SHEET LOCATION
EQUIPMENT IDENTIFICATION LOCATION
EXTENT OF DEMOLITION
FIXTURE TAG (LEVEL BELOW FIXTURE)
FOOD SERVICE EQUIPMENT / CALCULATION TAG
KEYED NOTE

PIPE BELOW GRADE
POINT OF CONNECTION
SECTION NUMBER AND SHEET LOCATION
DEMOLISH
EXISTING WORK
NEW WORK
PIPE OR CONDUIT BELOW GRADE

Piping Fittings

ACCESS PANEL
AQUASTAT
AREA DRAIN
BLIND FLANGE
CAP
CLEANOUT TO GRADE
CONCENTRIC REDUCER
DOWNSPOUT NOZZLE
ECCENTRIC REDUCER
EXPANSION JOINT
FLEXIBLE CONNECTION
FLOOR CLEANOUT
FLOOR DRAIN
FLOOR SINK
FLOW DIRECTION
FLOW SWITCH
HOSE BIBB / WALL HYDRANT
HUB DRAIN
METER
OVERFLOW ROOF DRAIN

PEX MANIFOLD
PIPE DROP
PIPE RISE
PRESSURE GAUGE WITH COCK
PUMP
ROOF DRAIN
SHOCK ABSORBER / WATER HAMMER ARRESTOR
STRAINER
T&P RELIEF VALVE WITH PIPE TO DRAIN
TEE DOWN ON PIPE
TEE UP ON PIPE
TEMPERATURE SENSOR
TEST PORT
THERMOMETER
TRAP PRIMER MANIFOLD
TRENCH DRAIN
UNION
VACUUM RELIEF
VENT THROUGH ROOF
WALL CLEANOUT

Piping Systems

140% HOT HOT WATER PIPING
140% HOT HOT WATER RETURN PIPING
ACID RESISTANT VENT PIPING
ACID RESISTANT WASTE ABOVE GRADE
ACID RESISTANT WASTE BELOW GRADE
COLD WATER PIPING
COMPRESSED AIR PIPING
CONDENSATE / INDIRECT DRAIN PIPING
DE-IONIZED WATER RETURN
DE-IONIZED WATER SUPPLY
DISTILLED WATER
FIRE PROTECTION PIPING
GAS VENT PIPING
GREASE WASTE ABOVE GRADE OR FINISHED FLOOR
GREASE WASTE BELOW GRADE OR FINISHED FLOOR
HOT WATER PIPING
HOT WATER RETURN PIPING
IRRIGATION
NATURAL GAS PIPING, 2 LB
NATURAL GAS PIPING, 7" WC PRESSURE
NON-POTABLE COLD WATER PIPING
NON-POTABLE HOT WATER PIPING
OVERFLOW DRAIN PIPING ABOVE GRADE OR FINISHED FLOOR
PUMPED DISCHARGE

REVERSE OSMOSIS WATER
SANITARY VENT PIPING
SANITARY WASTE OR SOIL PIPING ABOVE GRADE OR FINISHED FLOOR
SANITARY WASTE OR SOIL PIPING BELOW GRADE OR FINISHED FLOOR
SOLAR HOT WATER
SOLAR HOT WATER RETURN
STORM DRAIN PIPING ABOVE GRADE OR FINISHED FLOOR
STORM DRAIN PIPING BELOW GRADE OR FINISHED FLOOR
TEMPERED WATER PIPING
TRAP PRIMER PIPING

Valves

BACKFLOW PREVENTER
BACKWATER VALVE
BALANCING VALVE
CHECK VALVE
EARTHQUAKE GAS VALVE
ELECTRONIC SOLENOID VALVE
GLOBE VALVE
HOSE END DRAIN VALVE
NATURAL GAS PIPING CONNECTION ASSEMBLY
PRESSURE REDUCING VALVE
SHUTOFF VALVE, GENERAL

GENERAL PLUMBING NOTES

- A. CONDITIONS SHOWN ON PLANS RELATIVE TO THE WORK TO BE PERFORMED ARE BASED ON THE BEST INFORMATION AVAILABLE AND ARE SUBJECT TO CONTRACTOR TO FIELD VERIFICATION. VERIFY LOCATIONS AND ELEVATIONS OF UTILITIES TO BE CROSSED OR CONNECTED. CORRECT DEFICIENCIES CAUSED BY FAILURE TO PERFORM SUCH VERIFICATIONS AT NOT EXPENSE TO THE OWNER. IMMEDIATELY NOTIFY ARCHITECT OF CONDITION IN CONFLICT WITH THE DETAIL PLANS.
- B. PRIOR TO START OF WORK, THE GENERAL AND PLUMBING CONTRACTOR SHALL PERFORM SCOPING AND THOROUGH INVESTIGATION OF EXISTING SANITARY SEWER SYSTEM TO DETERMINE THE EXACT CONDITION IF PIPING, INVERT ELEVATION AND ROUTING.
- C. COORDINATE INSTALLATION OF PIPING BELOW AND ABOVE GRADE WITH STRUCTURAL COMPONENTS AND OTHER SYSTEMS INSTALLATION.
- D. COORDINATE FIXTURES, EQUIPMENT, PIPE ROUGH-IN / CONNECTION LOCATIONS AND DRAIN LOCATIONS WITH ARCHITECTURAL DRAWINGS.
- E. LOCATE SHUT-OFF VALVES FOR SERVICE ACCESSIBILITY. VALVES INSTALLED ABOVE CEILING SHALL BE WITHIN 18" OF CEILING.
- F. BECAUSE OF THE NATURE AND SCALE OF THE DRAWINGS, CERTAIN BASIC PLUMBING ITEMS SUCH AS UNIONS, FITTINGS, ELBOWS, ETC., MAY NOT BE SHOWN. WHERE SUCH ITEMS ARE REQUIRED BY THE NATURE OF THE WORK, OR BY CODES AND REGULATIONS, THEY SHALL BE FURNISHED AND INSTALLED AT NO ADDITIONAL COST TO THE OWNER. THE DRAWINGS INDICATE GENERAL LOCATIONS OF PIPING, THE EXACT LOCATION TO BE DETERMINED BY THE CONTRACTOR TO BEST FIT THE LAYOUT OF THE PROJECT.
- G. THE CONTRACTOR SHALL SEE THAT ALL MATERIALS, INSTALLATION AND WORKMANSHIP IS PERFORMED IN ACCORDANCE WITH THE LATEST EDITION OF ALL APPLICABLE CODES, LAWS, OR ORDINANCES AND LOCAL CODES, INCLUDING ALL STATE OR LOCAL BOARD OF HEALTH FEDERAL AND STATE ENVIRONMENTAL PROTECTION REGULATION, STATE ENERGY CODES.
- H. CONTRACTOR TO FIELD VERIFY ALL GAS FIRED EQUIPMENT AND COORDINATE WITH THE LOCAL GAS COMPANY FOR SIZE OF NEW METERS.
- I. CONTRACTOR TO COORDINATE WITH ARCHITECT/ OWNER FOR ALL NEW PLUMBING FIXTURES, SEE SCHEDULE CUT SHEET ON SHEET P0.2.
- J. CONTRACTOR TO FIELD VERIFY ALL DOMESTIC WATER PIPING THAT HAS BEEN REMOVED DUE TO VANDALISM THROUGH OUT THE BUILDING SHALL BE REPLACED WITH PEX TUBING WITH THE CORRECT PIPE SIZES. THE HOT, COLD & RETURN SHALL BE A COMPLETE WORKING ORDER SYSTEM WHEN DONE.

Mechanical approved by James Darnold
Exceptions has noted

Checking is only general conformance with the design concept of this project and general compliance with the information given in the contract documents. Any correction or comment are subject to the requirements of the plans and specifications. Contractor is responsible for dimensions which shall conform and correlated all of the job site, fabrication process and techniques of construction, coordination of work preformed with that of all trades and the satisfactory performance of work preformed and all codes requirements. All sections shall conform with all current adopted national and state mechanical codes

SHEET INDEX

P0.1 SYMBOL LIST AND GENERAL NOTES - PLUMBING
P0.2 SCHEDULES - PLUMBING
P1.0 FIRST FLOOR PLAN - PLUMBING
P1.1 SECOND FLOOR PLAN - PLUMBING
P1.2 ROOF PLAN - PLUMBING
P4.0 ENLARGED UNIT PLANS - PLUMBING
P4.1 ENLARGED ACCESSIBLE UNIT PLANS - PLUMBING



PROJECT 2022-1135
CONTACT TODD KOUBABA
100 SW Main Street, Suite 1600
Portland, OR 97204
TEL 503.382.2266
www.interfaceengineering.com



Andrew W. Fright
10.51.56-0700

HAVEN LIVING
3009 W HISTORIC HWY 66
GALLUP, NM 87301

SHEET TITLE

SYMBOL LIST AND
GENERAL NOTES -
PLUMBING

REVISIONS

DRAWN BY

TK

CHECKED BY

JMM

JOB NO.






2022-1372

DATE


03/31/2023

SHEET NUMBER

P0.1

Item	certificate Item	Picture	DESCRIPTION	Finish	QTY	
HL-102818S	102818S		Size 29 1/8" x 19 1/2" Material SUS304 Thickness 18 Gauge RD corner Bottom with slandering pad and spray coating With drainer accessories	Brushed	133	File No. 10966
006-4940	102818S		Material SUS304 With drainer accessories	PVD BLACK	133	
6555-RS-03	6555-RS-03		(1) 16" Faucet Height, 8" Spout Height and 9" Spout Reach (2) Ceramic cartridge, 900,000 times for open and close (3) Rotating 360° Bent Pipe (4) 60mm Bottom Sleeve, Faucet mounting hole Ø32mm (5) Suitable for all countertop installation (6) 1 Set flexible hose 3/8" female comp, 600mm including (7) US Patent Nut locking assembly, Easy and simple installation, More stable faucet With cUPC Certificate	Brushed	133	File No. 4974
6902	6902		(1) 12" Faucet Height, 8" Spout Height and 9" Spout Reach (2) Ceramic cartridge, 900,000 times for open and close (3) 60mm Bottom Sleeve, Faucet mounting hole Ø32mm (4) Suitable for all countertop installation (5) 1 Set flexible hose 3/8" female comp, 600mm including (6) Outlet with copper tube, (7) US Patent Nut locking assembly, Easy and simple installation, More stable faucet With cUPC Certificate	PVD BLACK	133	
62634-05	62634-05		(1) 14" NPT pipe thread Shower Arm (2) 304 stainless steel single function Square 12" Shower head (3) 90° rotation of transfer valve handle with stops (4) Pressure-balancing control valve, 300,000 times for open and close (5) Square panel, 150CM shower hose (6) 304 stainless steel single function handheld shower (7) including Tub Spout (8) Shower Head flow is limited to 1.5-2.5gpm at 80 psi (9) Handheld Shower flow is limited to 1.5-2.5gpm at 80 psi (10) Tub Spout flow is limited to 2.4gpm at 20 psi With cUPC Certificate	BLACK	133	

PLUMBING FIXTURE SCHEDULE-MODEL										
SYMBOL	FIXTURE TYPE	DESCRIPTION	BASIS OF DESIGN		ACCESSORIES	CONNECTION				COMMENT
			MFR	MODEL		W	V	CW	HW	
WM-1	OUTLET BOX	WASHING MACHINE OUTLET BOX (FIRE RATED) - NSF-372 COMPLIANT, ABS BOX/FRAME, NO-LEAD BRASS VALVES, ASSE 1010 WATER HAMMER ARRESTORS, 3/4" OUTLET CONNECTIONS, 2" DRAIN CONNECTION, INDIVIDUAL DRAIN AND SUPPLY BOXES	SIOUX CHIEF	696RG2313		2"	1-1/2"	1/2"		

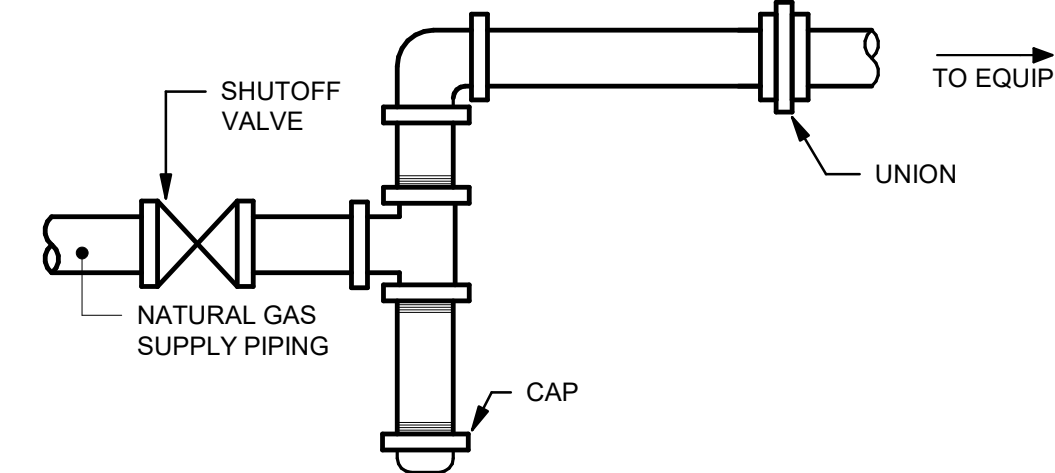

1 GAS CONNECTION DETAIL

NO SCALE

GAS CALCULATIONS				
FIXTURE	DESCRIPTION	NO. OF FIXT.	BTU/HR INPUT	TOTAL BTU/HR
MECHANICAL EQUIPMENT				
RTU-1	ROOF TOP UNIT	1	150,000	150,000
RTU-2	ROOF TOP UNIT	1	120,000	120,000
RTU-3	ROOF TOP UNIT	1	250,000	250,000
RTU-4	ROOF TOP UNIT	1	150,000	150,000
RTU-5	ROOF TOP UNIT	1	150,000	150,000
DOAS-01	DEDICATED OUTSIDE AIR UNITS	1	154,000	154,000
DOAS-02	DEDICATED OUTSIDE AIR UNITS	1	154,000	154,000
PLUMBING EQUIPMENT				
[]	DOMESTIC WATER HEATER	0	0	0
[]	DOMESTIC WATER HEATER	0	0	0
TOTAL DEMAND (BTU)				1,128,000
TOTAL DEMAND (CFH)				1,128
GAS: NATURAL GAS PIPING: SCH 40 STEEL SIZING BASED ON: 7" W.C. STD SUPPLY PRESSURE WITH 0.5 PSI PRESSURE DROP 250 FEET DEVELOPED LENGTH				
4"	4,560 CFH			
3"	1,980 CFH			
2-1/2"	1,120 CFH			
2"	704 CFH			
1 1/2"	366 CFH			
1 1/4"	244 CFH			
1"	119 CFH			
3/4"	63 CFH			
1/2"	30 CFH			

WATER SERVICE CALCULATIONS													
PRIVATE INDIVID. DWELLING	PRIVATE 3 OR MORE DWELLINGS	PUBLIC GENERAL USE	PUBLIC HEAVY USE ASSEMBLY	DESCRIPTION	PRIVATE INDIVIDUAL DWELLING	PRIVATE 3 OR MORE DWELLINGS	PUBLIC GENERAL USE	PUBLIC HEAVY-USE ASSEMBLY	TOTAL UNITS	(75) HOT WATER	WASTE FIXTURE PRIVATE	WASTE FIXTURE PUBLIC	TOTAL UNITS
				RETAIL SPACE	0.00	0.00	0.00	0.00	0.00	0.00	0.00	0.00	0.00
				SINK	1.00	1.00	2.00	2.00	0.00	0.00	2.00	0.00	0.00
	126			BATHTUB OR COMB. BATH/SHOWER	4.00	3.50	0.00	4.00	441.00	330.75	3.00	3.00	378.00
		1		HOSE BIBB	2.50	2.50	2.50	2.50	0.00	0.00	0.00	0.00	0.00
				HOSE BIBB (HW/CW)	2.50	2.50	2.50	2.50	0.00	0.00	0.00	0.00	0.00
		8		HOSE BIBB, EACH ADDITIONAL	1.00	1.00	1.00	1.00	8.00	0.00	0.00	0.00	0.00
	126			KITCHEN SINK, DOMESTIC	1.50	1.00	1.50	2.00	126.00	94.50	2.00	2.00	252.00
				LAUNDRY SINK	1.50	1.00	2.00	0.00	0.00	0.00	2.00	2.00	0.00
	126	7		LAVATORY	1.00	0.50	1.00	1.00	70.00	52.50	2.00	2.00	266.00
				SERVICE SINK OR MOP BASIN (2" TRAP)	0.00	0.00	3.00	3.00	0.00	0.00	3.00	3.00	0.00
		4		SERVICE SINK OR MOP BASIN (3" TRAP)	0.00	0.00	3.00	3.00	12.00	9.00	3.00	3.00	12.00
				SHOWER, EACH HEAD	2.00	2.00	2.00	2.00	0.00	0.00	2.00	2.00	0.00
		4		URINAL, 1.0 GPF	0.00	0.00	4.00	5.00	16.00	0.00	5.00	5.00	20.00
				WASHUP SINK, EACH SET OF FAUCETS	0.00	0.00	2.00	0.00	0.00	0.00	2.00	2.00	0.00
	126			WATER CLOSET, 1.6 GPF, GRAVITY TANK	2.50	2.50	2.50	4.00	315.00	236.25	3.00	6.00	378.00
				WATER CLOSET, 1.6 GPF, FLUSHOMETER TANK	2.50	2.50	2.50	3.50	0.00	0.00	3.50	8.00	0.00
		12		WATER CLOSET, 1.6 GPF, FLUSHOMETER VALVE	5.00	5.00	5.00	8.00	60.00	0.00	3.00	6.00	72.00
				FLOOR DRAIN - EMERGENCY	-				0.00		0.00	0.00	0.00
	6			FLOOR DRAIN - FD-1	3"				0.00		6.00	6.00	36.00
				FLOOR DRAIN - FD-2	4"				0.00		8.00	8.00	0.00
				FLOOR DRAIN - FD-3	3"				0.00		6.00	6.00	0.00
	4			FLOOR SINK - FS-1	4"				0.00		6.00	6.00	24.00
				TOTAL FIXTURE UNITS					1050.50	723.00			1438.00
				FLOW IN GPM					220.600	13.000	gpm		
				EMERGENCY SAFETY EQUIPMENT	30	GPM			0.000				
				COOLING TOWER MAKE-UP	30	GPM			0.000				
				HVAC MAKE-UP	30	GPM			0.000				
				IRRIGATION FLOW	20	GPM			0.000				
				TOTAL GPM REQUIRED					220.000	gpm			
	a.			MINIMUM DAILY SERVICE PRESSURE					84.000	(Water Service Room near Elevators))			
	b.			STATIC HEAD LOSS 434 /FT X	FT HG.T.				30.000				
	c.			WATER METER PRESSURE DROP	0	METER SIZE			5.000				
	d.	2		BACKFLOW PREVENTER	0				8.000				
	e.			PRESSURE REQUIRED AT FIXTURE					35.000				
				PRESSURE AVAILABLE FOR									
				FRICTION LOSS, a - b - c - d - e					6.000				
				TOTAL EQUIVALENT PIPE LENGTH									
	450	FT		LENGTH X 1.25					562.500				
				MAXIMUM FRICTION LOSS									
				PRESS. AVAIL. X 100/EQUIV. LENGTH					1.067				
				SYSTEM SIZED FOR 1.2 PSIG LOSS PER 100'									
				SERVICE SIZE FROM BUILDING PIPING					4"				
				SEWER LATERAL SIZE									8"



INTERFACE
ENGINEERING

PROJECT 2022-135
CONTACT TODD KOLIBABA
100 SW Main Street, Suite 1600
Portland, OR 97204
TEL 503.382.2266
www.interfaceengineering.com



Andrew W. Fridt
2023.05.11
10:51:56-0700

HAVEN LIVING

3009 W HISTORIC HWY 66
GALLUP, NM 87301

SHEET TITLE

FIRST FLOOR PLAN -
PLUMBING

REVISIONS

DRAWN BY

TK

CHECKED BY

JMM

JOB NO.


2022-1372

DATE

03/31/2023

SHEET NUMBER

P1.0

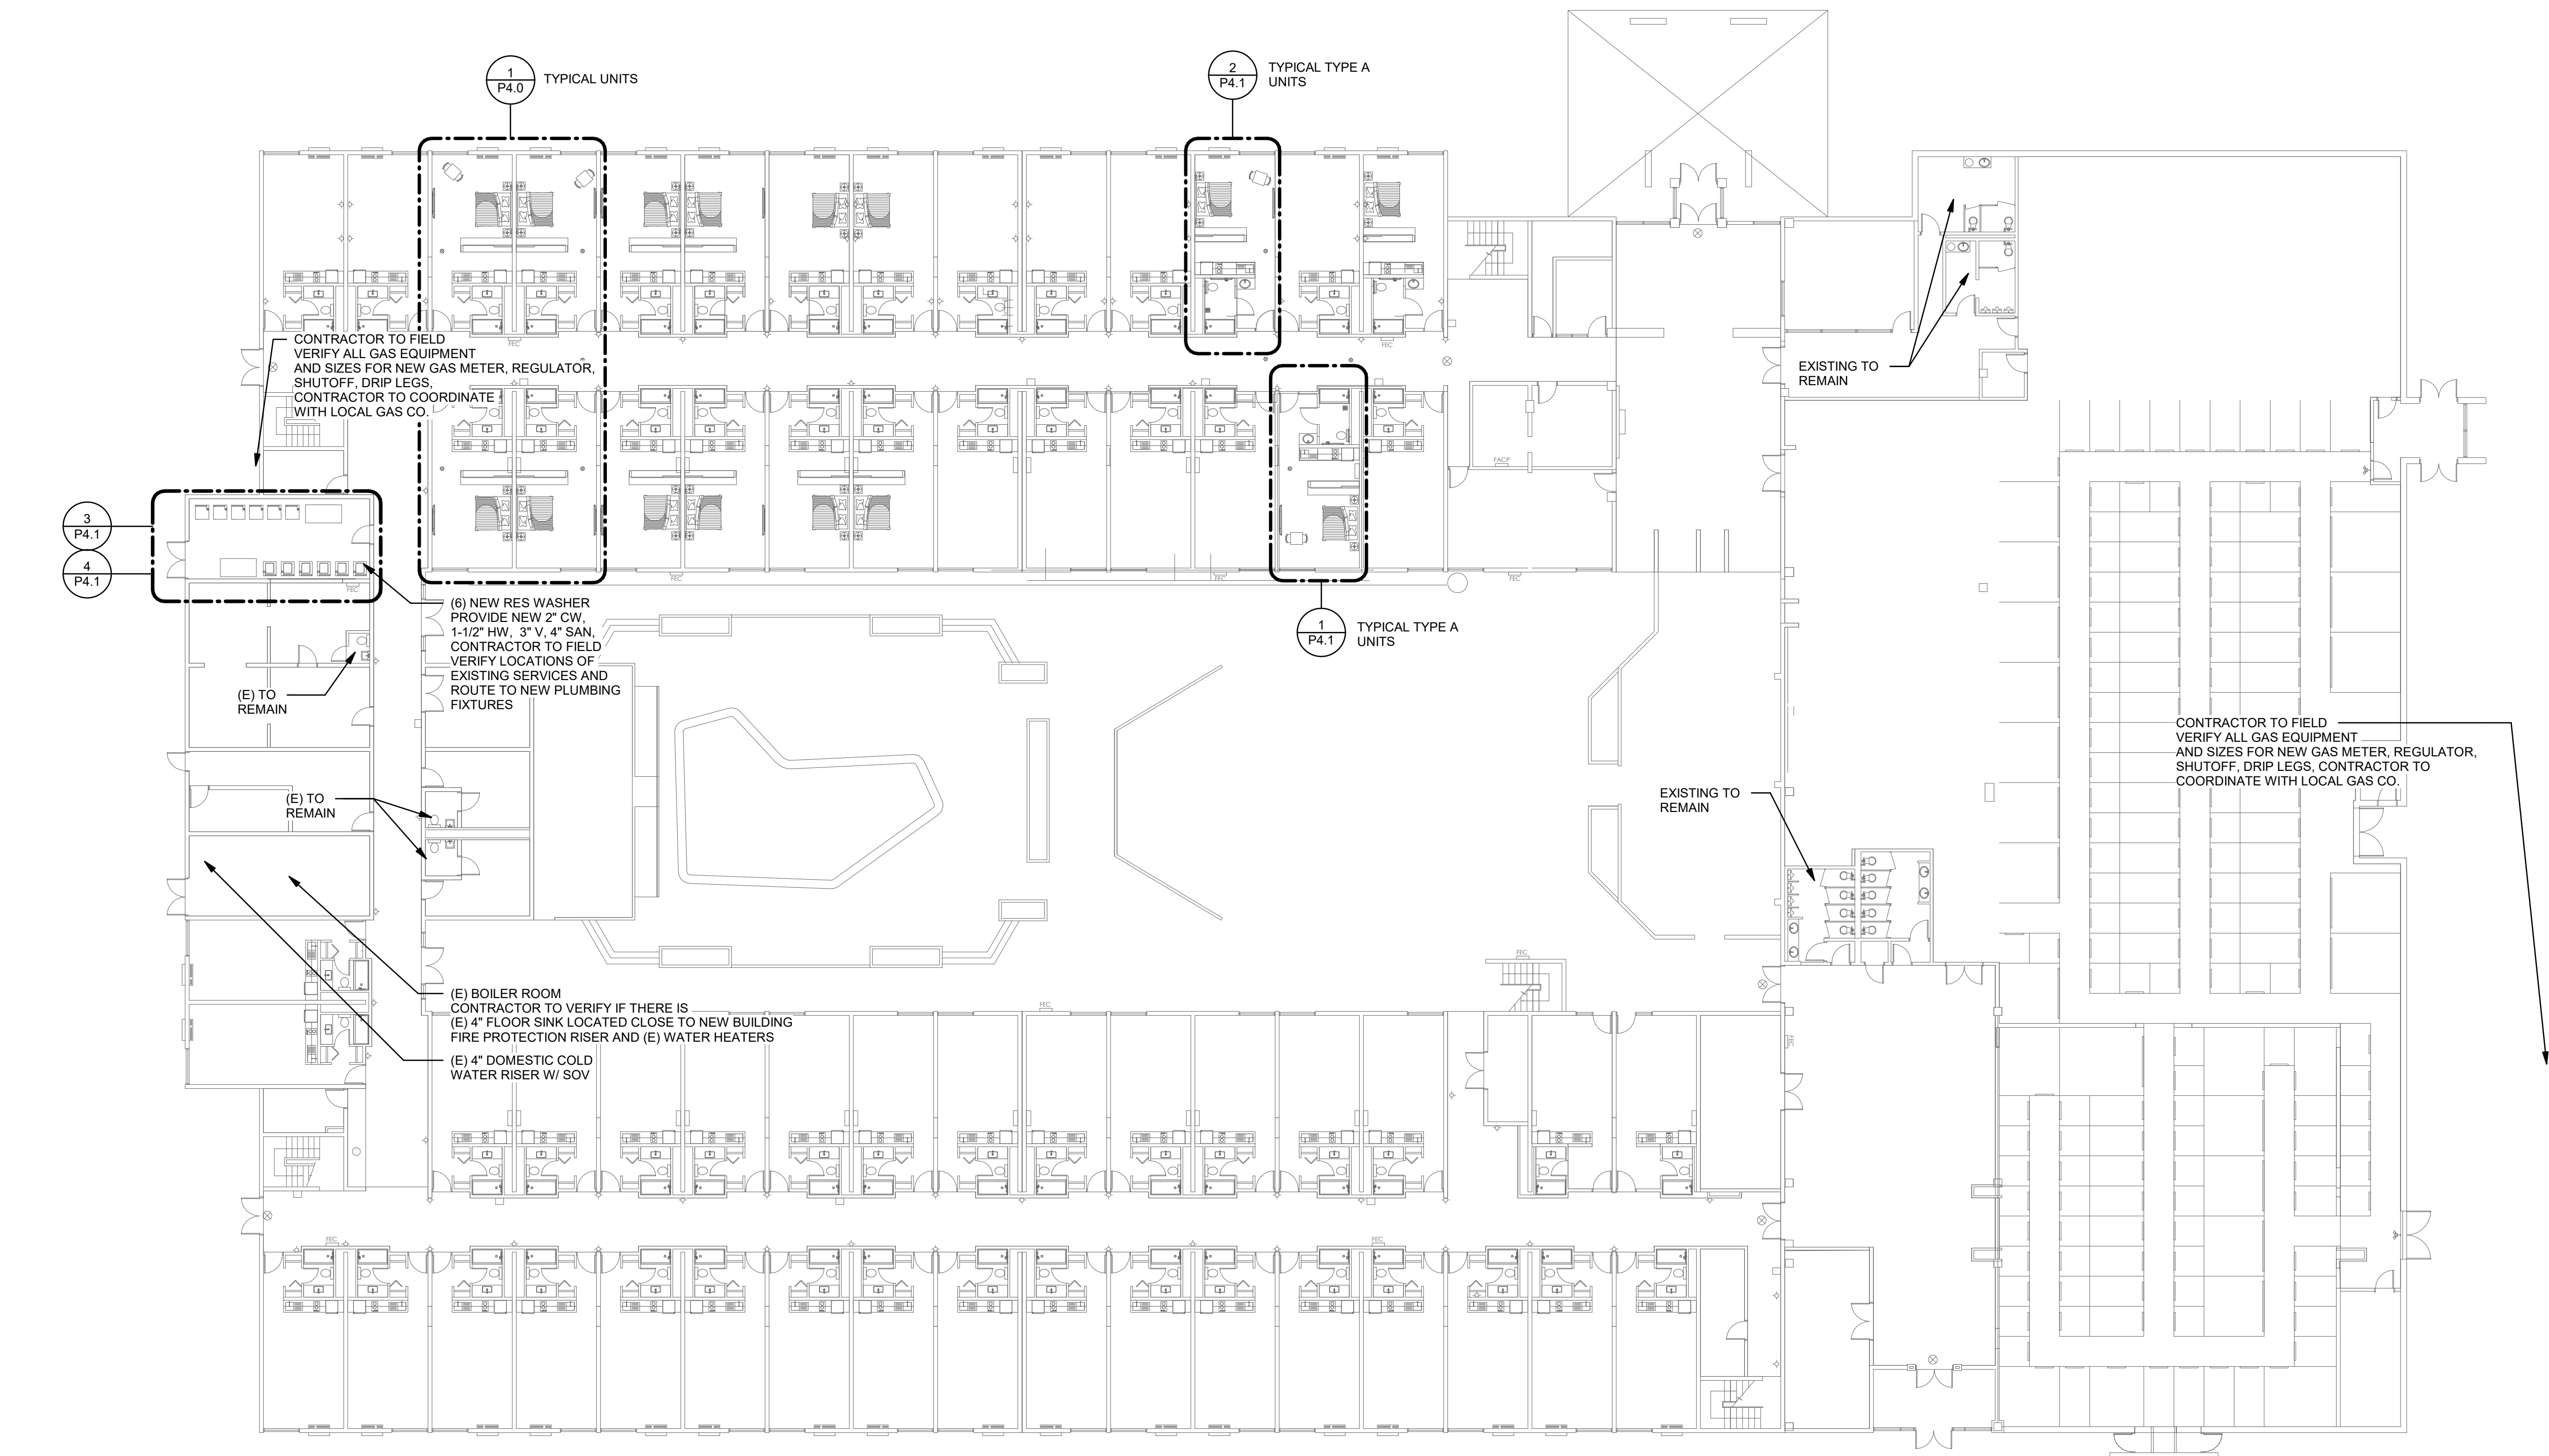

1 FIRST FLOOR PLAN - PLUMBING

0' 8' 16' 32'
1/16" = 1'-0"

Must comply with all national and state adopted codes



PROJECT 2022-1135
CONTACT TODD KOLIBABA
100 SW Main Street, Suite 1600
Portland, OR 97204
TEL 503.382.2266
www.interfaceengineering.com



Andrew W. Frichtl
2023.05.11
10:51:56-07'00'



Hangers and supports 313.2



1 SECOND FLOOR PLAN - PLUMBING

0' 8' 16' 32'

1/16" = 1'-0"

HAVEN LIVING

3009 W HISTORIC HWY 68
GALLUP, NM 87301

ET TITLE

COND FLOOR PLAN - UMBING

SIONS

NN BY

TK

CKED I

MM

NO.

2-1372

...

1/2023

ET NUMBER



P1.1



PROJECT 2022-1135
CONTACT TODD KOLIBABA
100 SW Main Street, Suite 1600
Portland, OR 97204
TEL 503.382.2266
www.interfaceengineering.com



Andrew W. Frichtl
2023.05.11
10:51:56-0700'

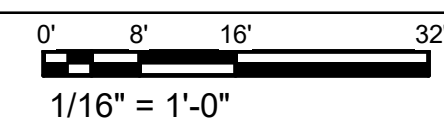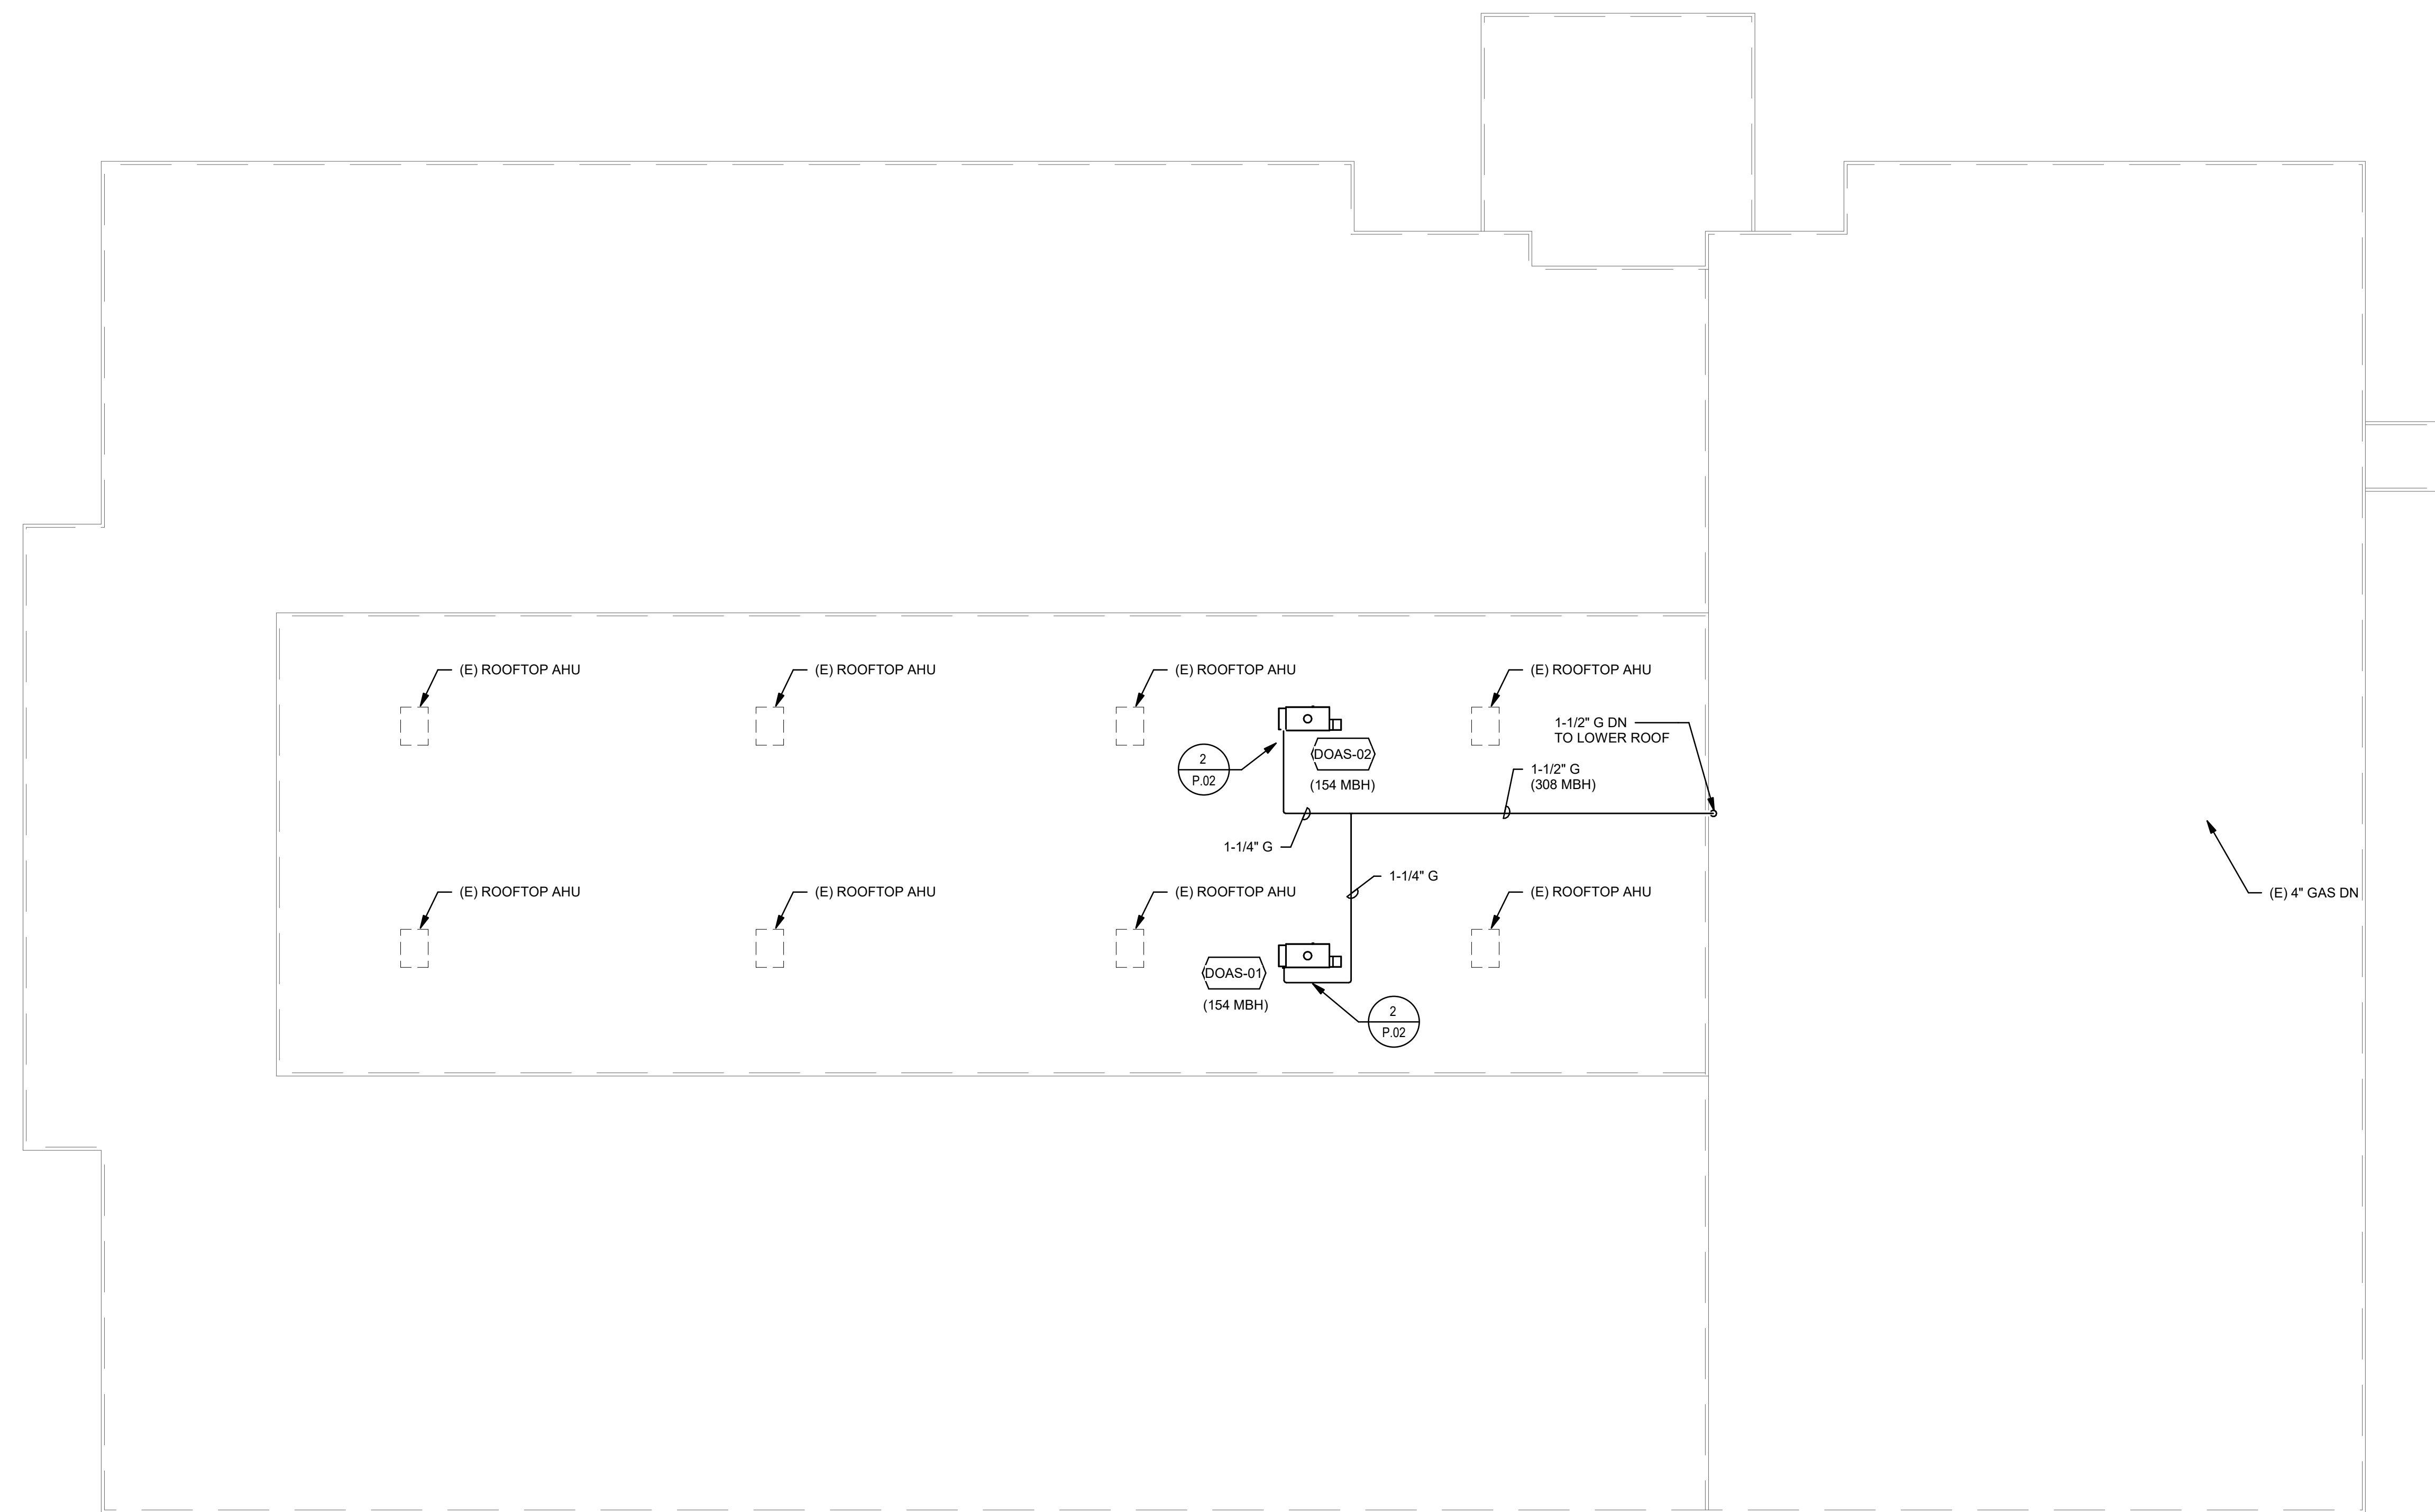

HAVEN LIVING

3009 W HISTORIC HWY 66
GALLUP, NM 87301

OF PLAN - PLUMBING

[illegible]

DRAWN BY	Author
CHECKED BY	Checker
DOB NO.	2022-1372
DATE	03/31/2023
SHEET NUMBER	


Must comply with all national and state adopted codes

P1.2



SHEET KEYNOTES

1. NEW KITCHEN SINK COORDINATE WITH OWNER , SEE SCHEDULE ON SHT. P0.2.
2. EXISTING FIXTURES TO REMAIN.
3. EXTEND 1/2" HW, 1/2" CW TO NEW KITCHEN SINK, ROUTE 2" SAN , 1-1/2" VENT IN WALL AND CONNECT TO EXISTING SERVICES.
4. ROUTE 3/4" CONDENSATE TO THE NEAREST SINK OR LAVATORY TAILPIECE.

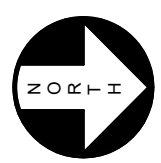

1 FLOOR PLAN TYPICAL UNITS - PLUMBING

Must comply with all national and state adopted codes

HAVEN LIVING

3009 W HISTORIC HWY 66
GALLUP, NM 87301

SHEET TITLE

ENLARGED UNIT PLANS
- PLUMBING[illegible]

DRAWN BY

TK

CHECKED

MM

JOB NO.

2-1372


DATE _____

1/2023


SHEET NUMBER

P4.0

1. KITCHEN SINK COORDINATE WITH OWNER, SEE SCHEDULE ON SHT. P0.2
2. NEW ADA WATER CLOSET COORDINATE WITH OWNER FOR MAKE AND MODEL.
3. NEW ADA SHOWER AND SHOWER VALVE. COORDINATE WITH OWNER, SEE SCHEDULE ON SHT. P0.2
4. EXISTING FIXTURE TO BE REUSED.
5. ROUTE CONDENSATE TO THE NEAREST TAILPIECE.
6. ROUTE NEW 4" SANITARY SEWER TO THE NEAREST EXISTING, CONTRACTOR TO FIELD VERIFY EXISTING LOCATION.
7. CONTRACTOR TO VERIFY THERE IS A FLOOR DRAIN IN THE SPACE, IF NO FLOOR DRAIN A 3" FLOOR DRAIN WILL NEED TO BE ADDED, VENT AND TRAP PRIME PER CODE.
8. ROUTE NEW 1-1/2" COLD, 1-1/4" HOT WATER TO THE NEAREST SERVICES, CONTRACTOR TO FIELD VERIFY EXISTING LOCATION.
9. ROUTE NEW 3" VENT TO THE NEAREST SERVICES, CONTRACTOR TO FIELD VERIFY EXISTING LOCATION.

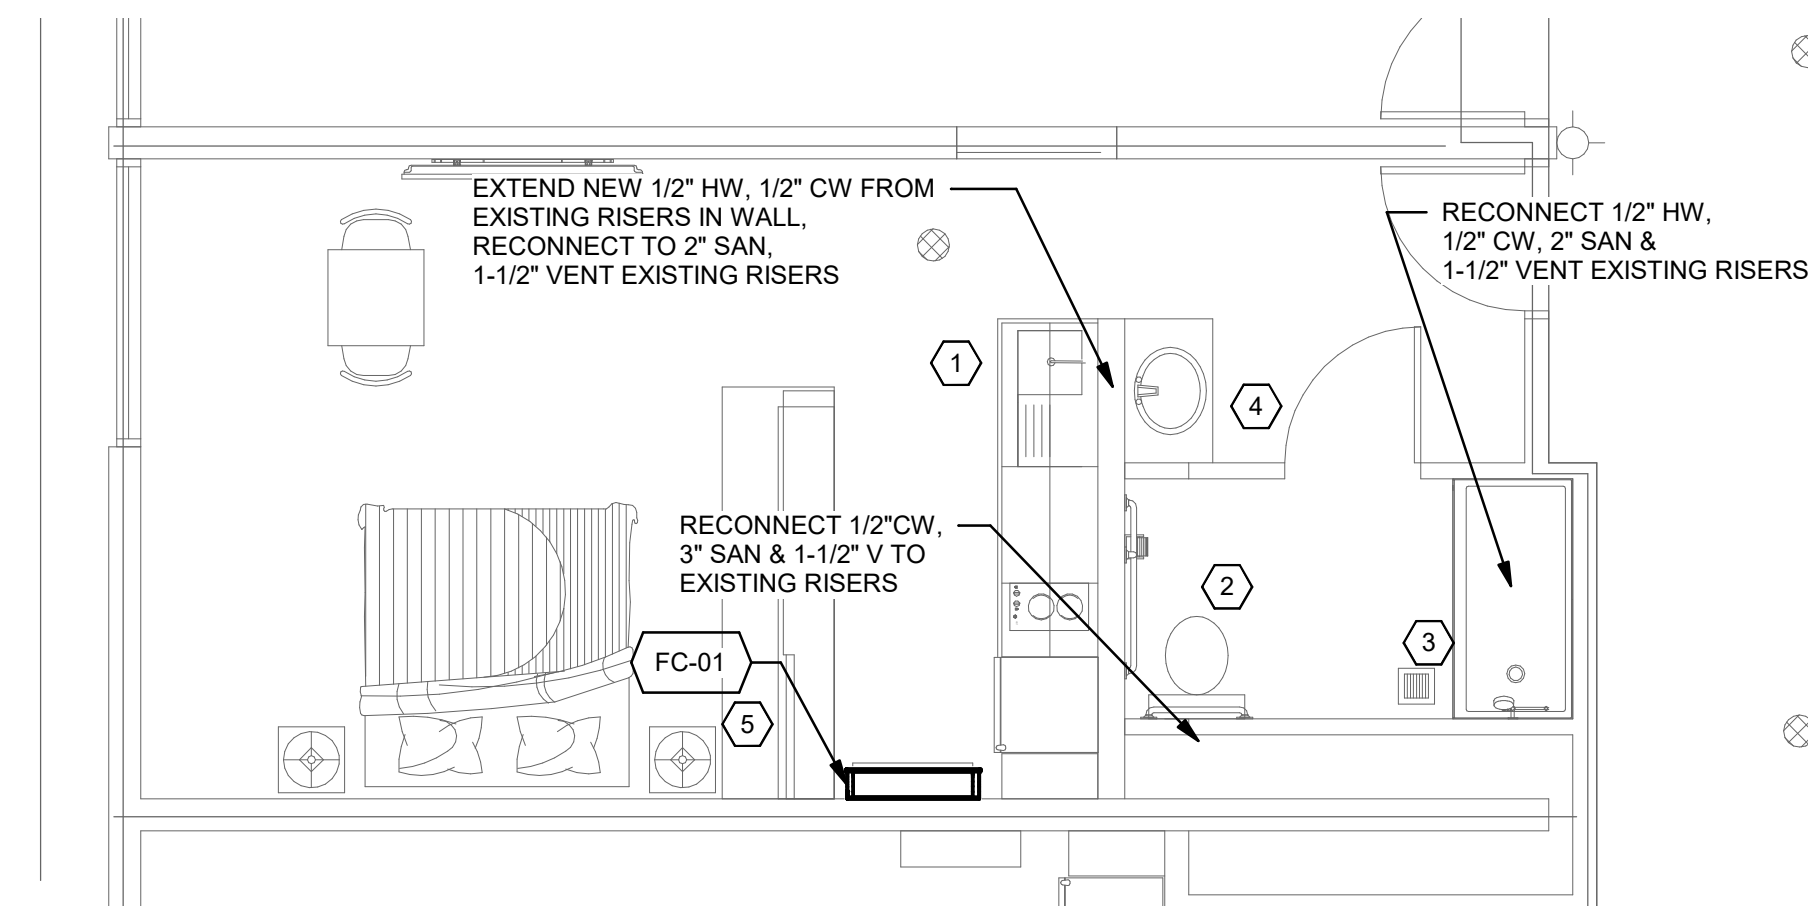


1 ENLARGED FLOOR PLAN TYPE A UNIT - PLUMBING

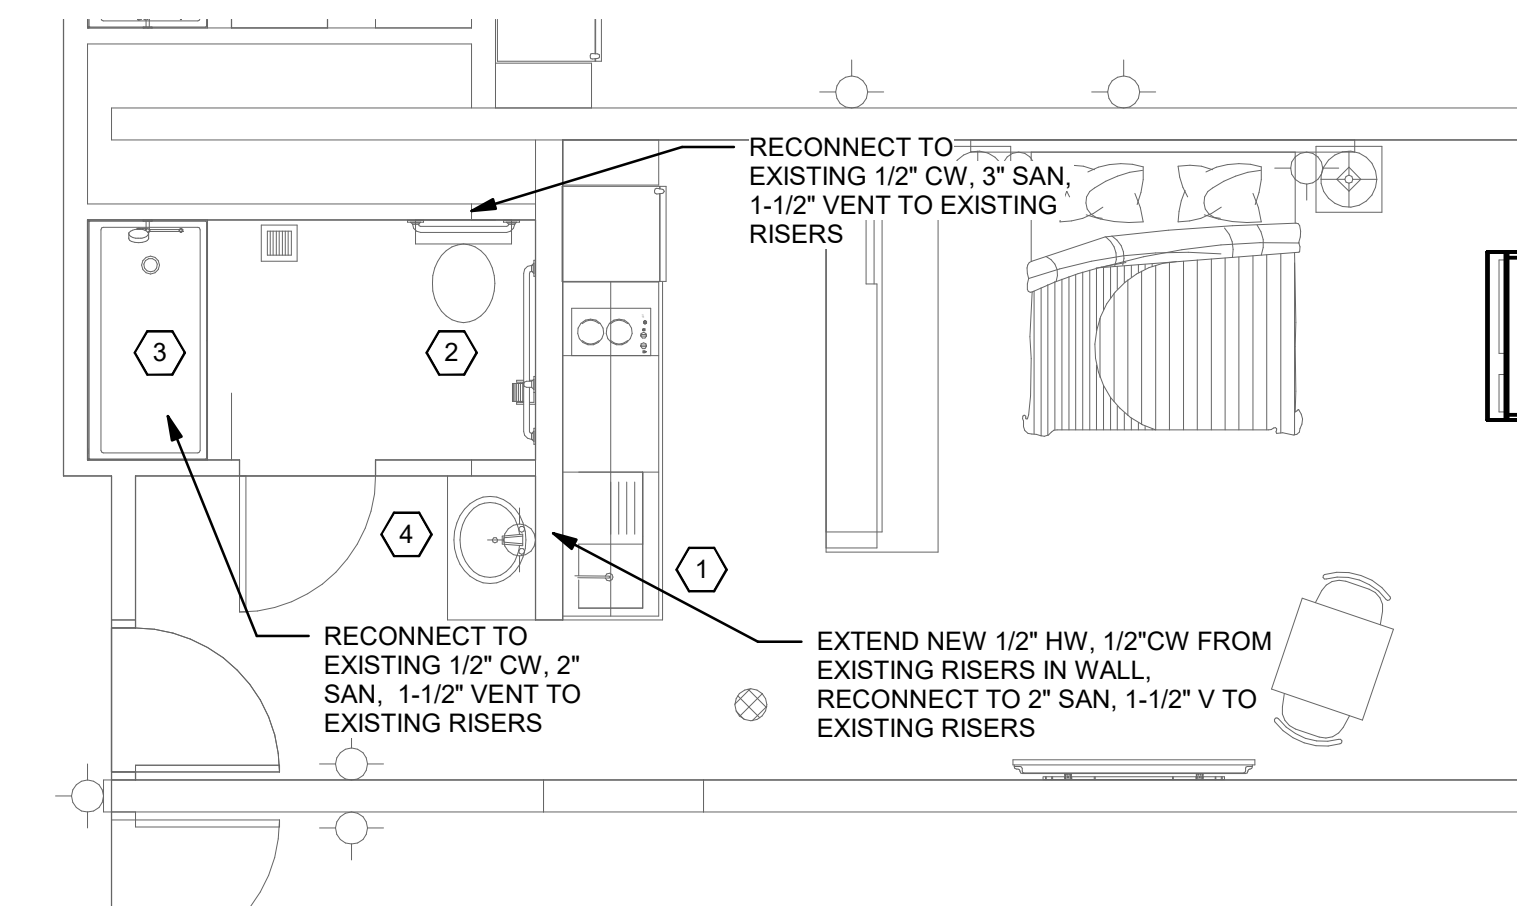


2 ENLARGED FLOOR PLAN TYPE A UNIT - PLUMBING

Water hammer 609.11

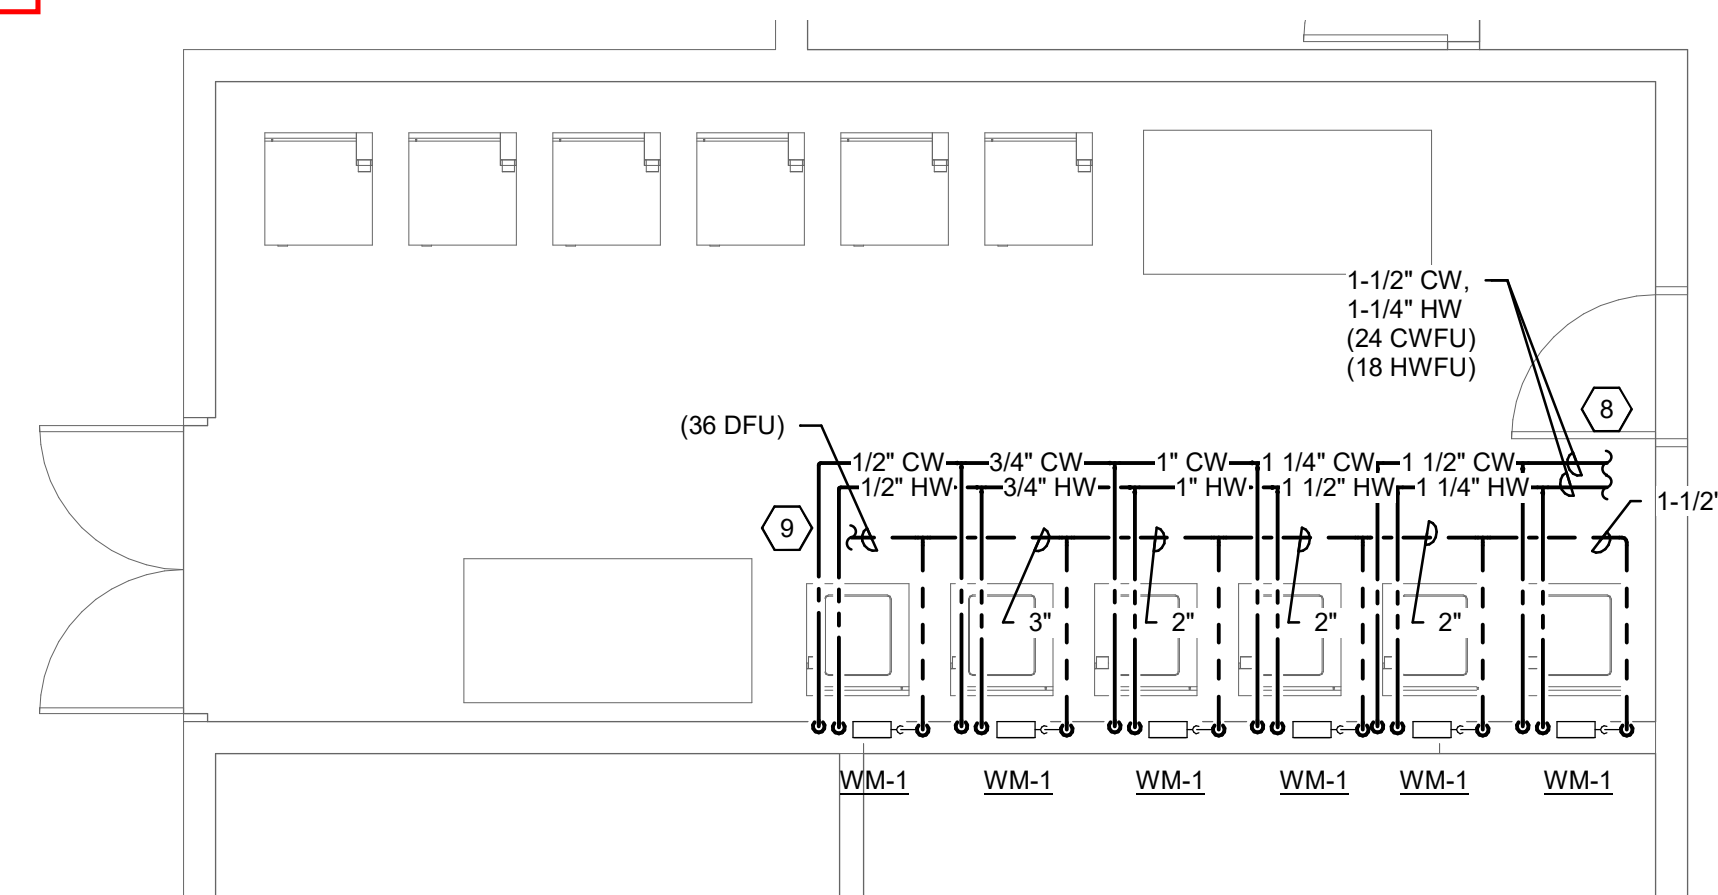

3 ENLARGED PLAN - LAUNDRY ROOM - PLUMBING

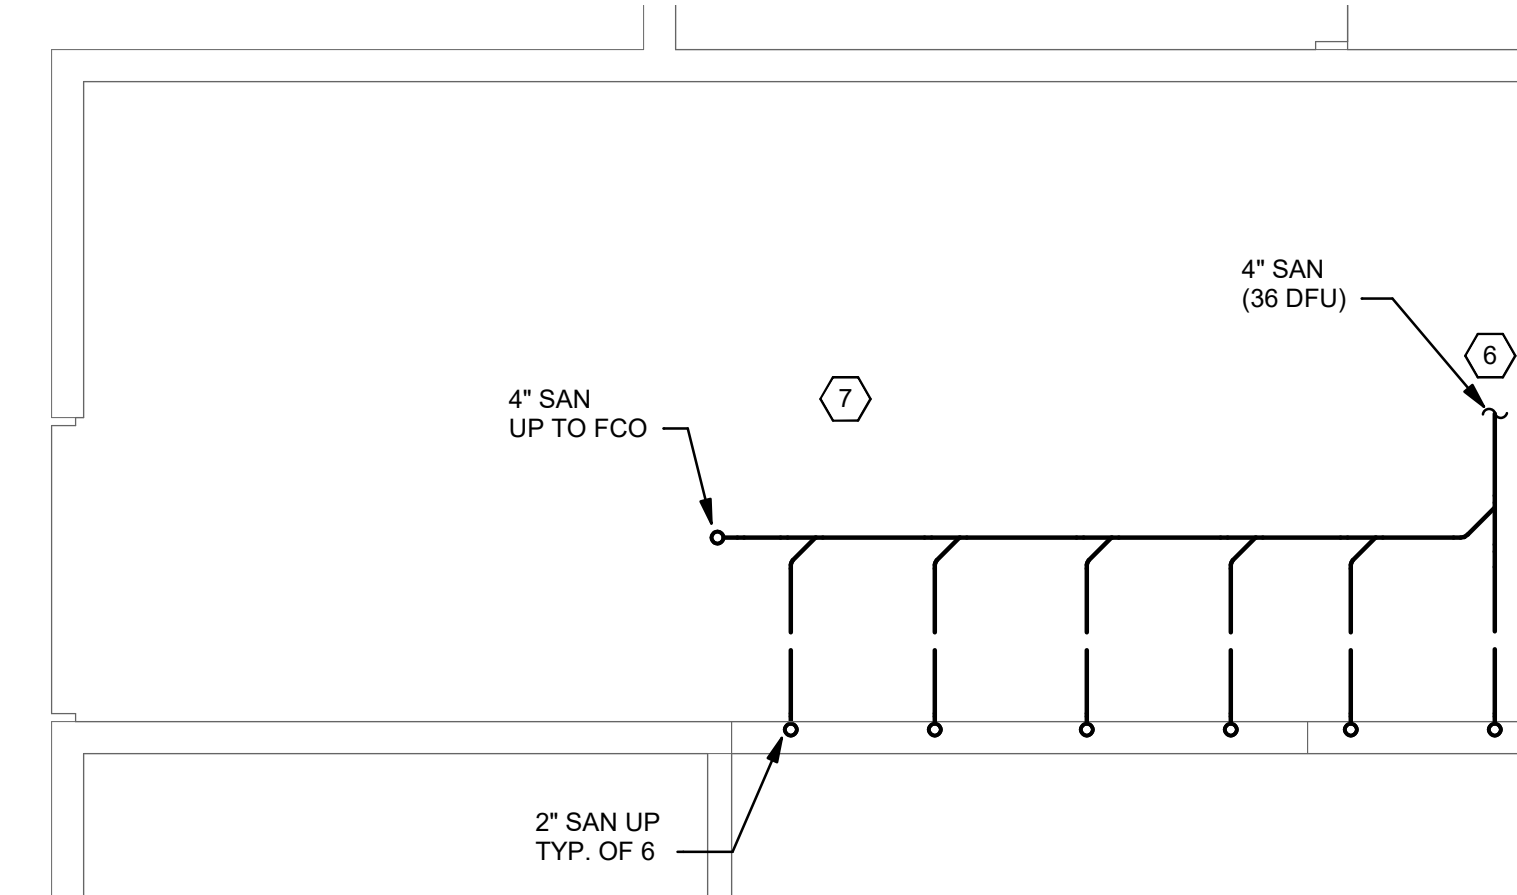

4 ENLARGED PLAN - LAUNDRY ROOM - UNDERGROUND - PLUMBING

Must comply with all national and state adopted codes

HAVEN LIVING

3009 W HISTORIC HWY 66
GALLUP, NM 87301

SHEET TITLE

ENLARGED ACCESSIBLE
UNIT PLANS - PLUMBING

REVISIONS

DRAWN BY TK

CHECKED BY JMM

OB NO. 2022-1372

03/31/2023

SHEET NUMBER

P4.1